ADD: Detail 19 as shown in Drawing CA-04.

52

1 This Addendum is hereby made a part of the Contract Documents to the same extent as though it were 2 originally included therein. 3 4 5 ARCHITECTURAL 6 7 8 SPECIFICATIONS: 9 10 INSTRUCTIONS TO BIDDERS, Article 1.11, E: 11 CHANGE: "October 8, 2014" to "February 23, 2015". 12 AIA A201, GENERAL CONDITIONS OF THE CONTRACT, Section 11.4.3: 13 14 CLARIFICATION ONLY: As directed in the last sentence of this section, Electrical, HVAC, & 15 Plumbing subcontractors are required to bond, and the costs for those bonds must be included in the 16 Base Bid, in accordance with INSTRUCTIONS TO BIDDERS, Article 1.07, C." 17 SECTION 01 10 00, SUMMARY OF THE WORK, Page 2, Line 13: 18 19 <u>CHANGE:</u> Sum to: "\$1,500.00" (To agree with INSTRUCTIONS TO BIDDERS, Article 1.11, E). 20 21 SECTION 03 30 00, CONCRETE WORK: 22 Page 5, Lines 16-18: 23 DELETE: Lines 16-18 entirely. Not used on this project. 24 25 Page 12, Lines 20-21: 26 DELETE: "At Room 505 level to 1/8" in 10'-0"." 27 28 SECTION 09 29 00, GYPSUM DRYWALL, Page 12, Lines 34-35: 29 CHANGE TO READ: "Level 3: Mechanical Rooms and Mechanical Closets. Taped as in Level 2, then covered with two 30 31 separate coats of joint compound. Joint compound shall be smooth and free of tool marks and 32 ridges." 33 SECTION 11 66 23, GYMNASIUM EQUIPMENT: 34 35 Page 2, Line 31: 36 CHANGE TO READ: 37 "..folding backstops equal to Porter Model 90949-000. Equip with Model 00204-000 42" x 38 72" glass.." 39 Page 2, Line 45: 40 41 CHANGE TO READ: 42 "..equal to Porter Model 90955-000. Equip with Model 00204-000 42" x 72" glass 43 backboards, Porter.." 44 45 DRAWINGS: 46 47 SHEET A4.01, EXTERIOR ELEVATIONS, Elevation 7: 48 49 ADD: Louver over Door 001A as shown on Drawing CA-03. 50 51 SHEET A5.04, EXTERIOR DETAILS:

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30 31 32 SHEET A6.02, ENLARGED WEST STAIR PLANS AND SECTIONS, Enlarged Plan 3:

<u>ADD:</u> Dry sump in elevator pit as shown on Drawing CA-01.

SHEET A6.03, STAIR DETAILS:

ADD: Detail 24 as shown on Drawing CA-02.

PRIOR APPROVALS:

The following products are approved for bidding subject to review and approval of Submittals and provided the Manufacturer meets all the requirements of the originally specified product. It shall be the initiator's responsibility to ensure that the proposed substitution is equal in every respect to the originally specified product, including but not limited to finish, size, weight, clearances, durability, maintenance, ease of operation, performance criteria, etc.

SECTION 07 54 23, THERMOPLSTIC SINGLE-PLY MEMBRANE ROOFING:

Thermoplastic Polyolefin (TPO) Sheet:

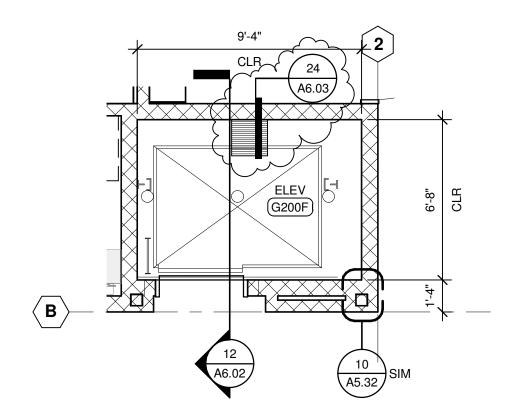
GAF Everguard TPO, 60 mil Membrane.

Mule-Hide TPO-c

MINUTES OF PRE-BID CONFERENCE:

On February 19, 2014, the Owner conducted a pre-bid conference to discuss the project and tour the work site. Minutes are attached hereto and incorporated by reference.

END OF ARCHITECTURAL ADDENDUM NO. 1



ENLARGED FIRST FLOOR ELEVATOR G200F PLAN

3 Scale: 1/4'' = 1'-0''

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SPOKANE PUBLIC SCHOOL DISTRICT NO. 81

SALK MIDDLE SCHOOL GYMNASIUM REPLACEMENT

6411 N ALBERTA STREET, SPOKANE, WASHINGTON 99208



NAC NO: 111-11087

FILE:

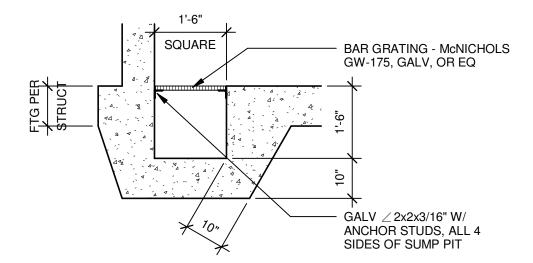
DRAWN: MSC

CHECKED: MJC

MJC 02/21/14 CA-01

E: 3/A6.02 ADDENDUM #1

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24 DRY SUMP PIT Scale: 1/2" = 1'-0"

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NAC NO: 111-11087

FILE:

DRAWN: MSC

CHECKED: MJC

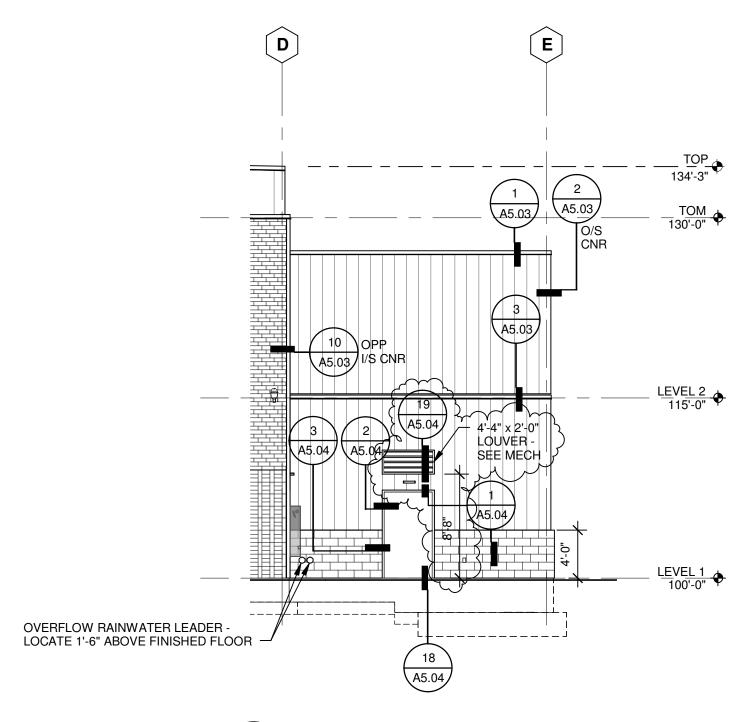
DATE: 02/21/14

CA-02

RE: 24/A6.03

ADDENDUM #1

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WEST ELEVATION

Scale: 1/8" = 1'-0"

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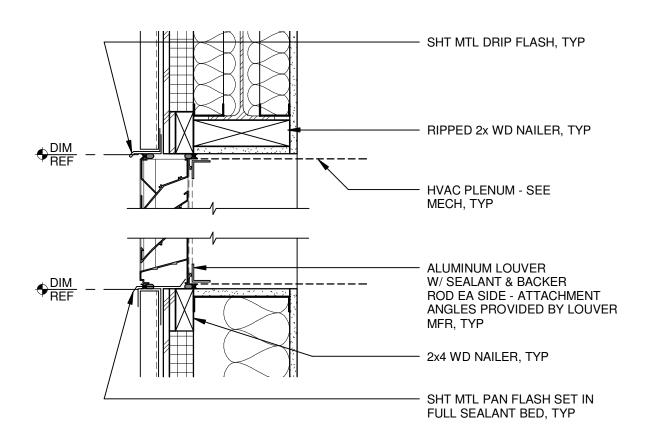
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CHECKED: MJC

DATE: 02/21/14

CA-U3RE: 7/A4.01

ADDENDUM #1



LOUVER HEAD / SILL (JAMB SIM) 19 Scale: 1 1/2" = 1'-0"

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NAC NO: 111-11087 RDP CHECKED: MJC

DATE:

RE: 02/2114

19/A5.04 ADDENDUM #1

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Pre-Bid Conference - Minutes

Project: Salk Middle School Replacement -

Phase 1

Date/Time: February 19, 2014, 4:00 pm

NAC No. 111-11087 22-1314

Owner Bid No.

IN ATTENDANCE

Owner's Representatives:

Mike Keenan, Spokane Public Schools - Capital Projects Barbara Carson, Spokane Public Schools - Purchasing

Design Team:

Michael Cole, NAC|Architecture - Architectural

Matt Gibb, DCI Engineering - Civil

Bruce Turner, NAC|Engineering - Electrical

Prime Bidders, Subcontractors, Suppliers:

(Refer to attached Sign-In Sheet)

AGENDA

The agenda is not a bid document or contract document; thus, it is omitted from this set of minutes, which is incorporated into the contract documents via addendum.

QUESTIONS/COMMENTS

- 1. The Purchasing Department requests that each bidder clearly mark the outside of each bid package with the contents: "Base Bid" or "Alternate Bids & Subcontractor List".
- 2. **Q:** What area is designated as the contractors lay-down area?

A: Refer to Sheet A1.02, SITE PLAN: The Contractor may occupy the area within the existing semi-permanent fence for any and all purposes related to the work in this project. The Contractor may not occupy areas outside the semi-permanent fence except as directly necessary to perform the work in this project, such as installation of utilities outside of the fenced area. Contractor parking is not allowed on-site outside of the fenced area.

With the approval of the City of Spokane, and approval of Spokane Public Schools designated representative(s), the Contractor may also be allowed to occupy the portion of Lindeke Street adjacent to the school site for temporary purposes such as daytime parking.

3. **Q:** What is the school calendar?

A: Refer to Spokane Public Schools' website for the 2013-14 school calendar. http://www.spokaneschools.org/cms/lib/WA01000970/Centricity/Domain/36/S PS%202013-2014%20Calendar%20-%20Approved.pdf

The 2014-15 school year calendar is not available at this time.

 Q: What is the school class schedule?
 A: Refer to Salk Middle School's website for the current bell schedule. http://www.spokaneschools.org/domain/1121

Please contact the Architect if you have any corrections to these minutes.

Prepared by: Michael Cole, AIA



CAPITAL PROJECTS & PLANNING

2815 East Garland Avenue Spokane, WA 99207-5889

(509) 354-5775 phone (509) 354-7178 fax

Salk Middle School Replacement - Phase 1

Bid No. 22-1314
MANDATORY Pre-Bid Conference
February 19, 2014 at 4:00 p.m.

Sign-In Sheet

Name			
<u>iname</u>	Representing	Phone No.	Email
Cotton Jacobsson	Anderson Masoney, Inc	509.534.2652	Colton & Andreson masoney inc. com
TOHN CANNON	JACKSON CONTRACTOR LA	406-512-9150	THAT WE WE WAS IN SHOW
Tony Marmon	Trademark Mechanical	(208)772-5269	Tralemark Mechanical @yohan
TOM MORROW	GARCO CONST	*	TOME GARCO, COM
JOHN COE	PCI		JOHN. COFE Pitale
Luke A. Ovlando	MACKIN? LITTLE		lorlando@mackinlittle.c
BrandonSouth	Associated Conest.		brandon cacispokano con
PETER SMITH	ASSOCIATED CONST.		preeci spkque-com
KEITH YADEN	AGEÉ ELECTEIC	509-951-1016	KEITH G AGEE ELELTEIC, G
ROBERT FRAZIER	MERIDIAN CONSTRUCTION	509-443-6252	robert@meridianco.com
REN RADOSLOVICH	LYDIG CONSTRUCTION	509-534-0451	BRADOSLOVICH QLYDIG.CO
Tony Via	Inland Asphalt	509	TVia @ oldcustlemoterids.com
TERRY RIZZUTO	MOUNTI-INSTATES ELECTRIC		terry@ MTHST, Con
Mike Symmers.	T. 1 01 1/1 1	1509) 927-0800	Scott@ twllgrk.com
Clay Barney	VTI Electric	509-944-0840	Charney entirelection
Scott Wright	Swank Enterprises	406-279-3241	Swright @ swent con



CAPITAL PROJECTS & PLANNING

2815 East Garland Avenue Spokane, WA 99207-5889

(509) 354-5775 phone (509) 354-7178 fax

Salk Middle School Replacement - Phase 1

Bid No. 22-1314

MANDATORY Pre-Bid Conference
February 19, 2014 at 4:00 p.m.

Sign-In Sheet

N.				
Name	Representing	Phone No.	Email	
MAZHANS JAVIS	Wision Stars Pors,	509-892-0600	WSCOAIR-PIPZ COM	
JON SPILKER	WALKER CONST. GC.	535-3354	JSPILKER WALKER	
BOB JOHNSON	INTERMOUNTAIN E	wii 370-050	bobs 1 wher maintain	. W (
Statt Vanderer	Three V Phumbing	208-773-3600	Hura V Plumbing @ Frantier.	, co
Jeff Gallaghen		509-795-5883	igallagher Obuhecgi.	Co~
Jeff Weaver	GRAHAM	509-534-1030	mikeje grahamusico	m
TY Schuetzle	MJM CHAND INC.	509-244-4733	Tyen, marandinet	
George Paupst	Blews Constr.	5099286727	blews o blews corstanct	ren E
Dewight West	Siemens	509-290-0448	dewignt. westesiemens.e	om
KRIS PERETRA	GINNO CONST CO	203-667-556	KRISEGENNOCONISTEUCI	الكو
Jeff Kilgore	Kilgor Const., luc.	509-238-0703	Jetta Alger constructioning	con
JAD KILLORE	KILLOPE CONSTRUCTION, WC	509-238-0703	Jad@KILLORECONSTRUCTION/INC	COM
CRAIG GRAVES	PRO Mechanical	509-954-6273	Cgraves@pro-msi com	_
Brad on Jovell	Sturn Heating	509-252-5436	bridmesturnhesting, or	on
Bran Chapman	Archie Lighting	533-9350	priar degna 20 concast.	
			concast	al 1

ADDENDUM NO. 1 February 21, 2014 Page M-1

NAC|Architecture, 111-11087

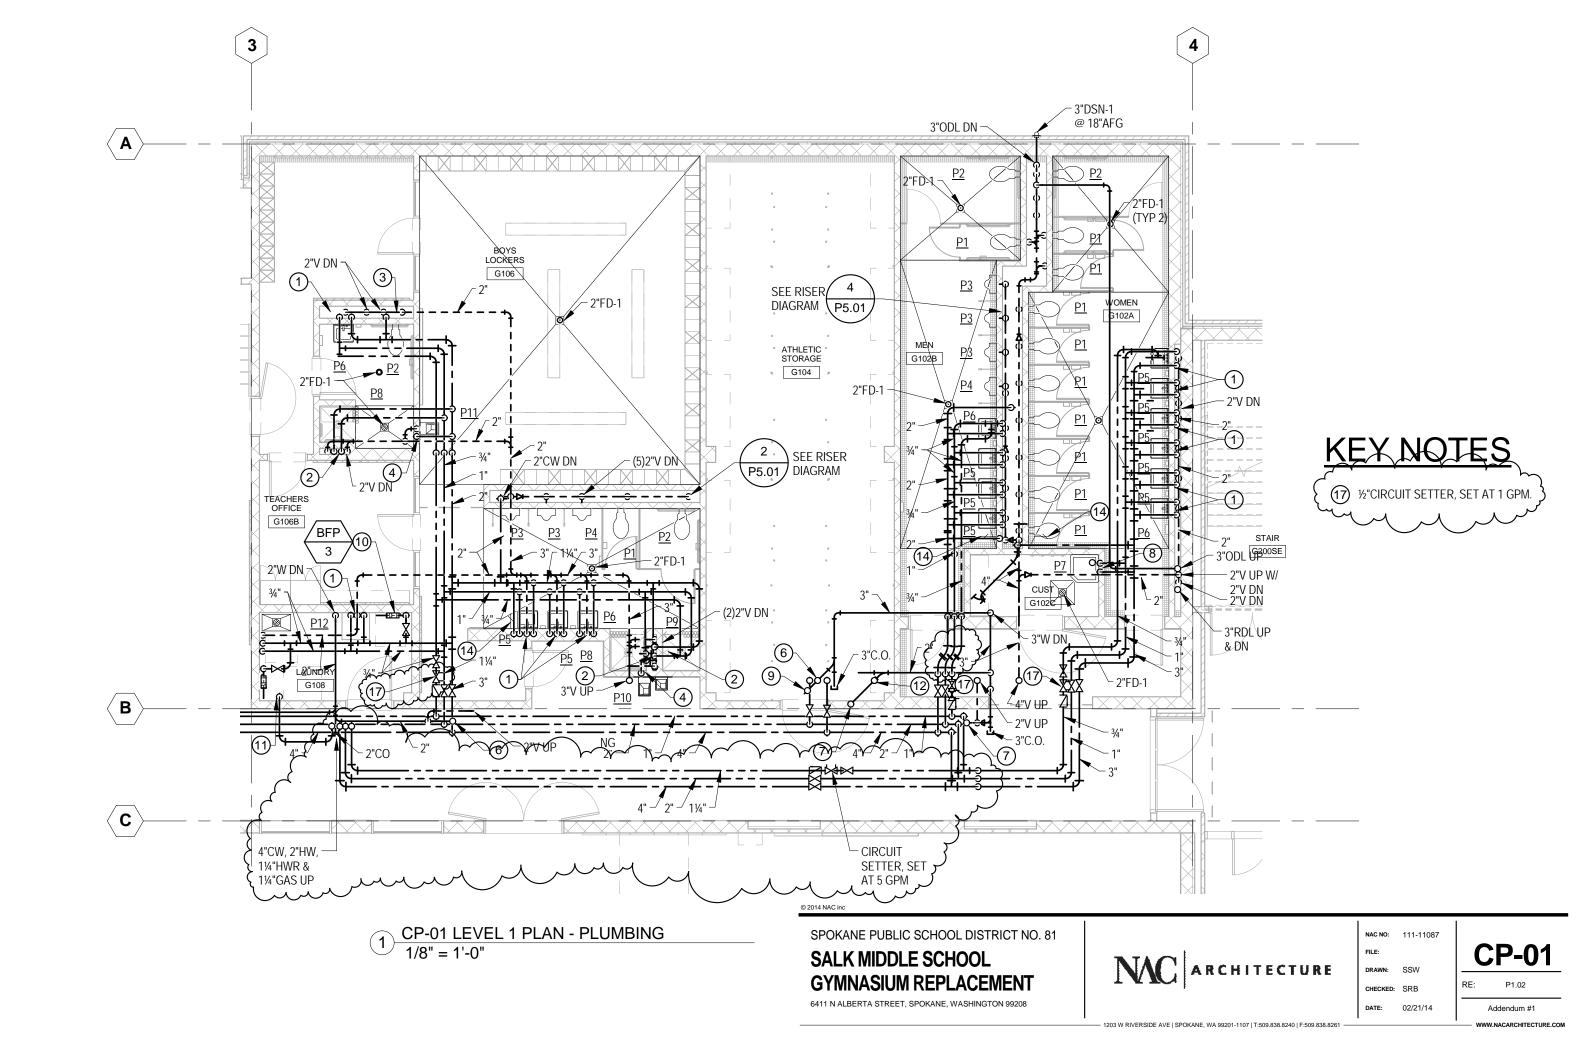
1 2 3	This Addendum is hereby made a part of the Contract Documents to the same extent as though it were originally included therein.
4	PLUMBING
5 6	<u>DRAWINGS:</u>
7 8 9 10 11 12 13 14 15 16	SHEET P0.01, SCHEDULES: <u>ADD:</u> FD-3 to floor drain schedule. Drain shall be model no. 2110Y as manufactures by Jay R. Smith.
	SHEET P1.02, LEVEL 1 FLOOR PLAN - PLUMBING: REVISE: Domestic water supply routing in the north side of the gym in the corridor see sheet CP-01 & CP-02. ADD: Isolation valves at locker rooms. See sheet CP-01& CP-02. ADD: Circuit setter call out – key note. See Sheet CP-01&CP-02.
17 18 19 20 21	SHEET P1.03, LEVEL 2 FLOOR PLAN - PLUMBING: <u>REVISE</u> : Domestic water supply routing in the north side of the gym in the corridor see sheet CP-
22 23	MECHANICAL
24 25	SPECIFICATIONS:
26 27 28 29 30	SECTION 23 21 13, HYDRONIC PIPING REVISE: Paragraph 3.1.1.B.2 to read "Under Alternate 5" REVISE: Paragraph 3.1.1.D.2 to read "Under Alternate 5"
31 32 33	<u>DRAWINGS:</u>
34 35 36 37 38 39 40 41 42 43 44 45 46 47 48 49 50 51 52 53	SHEET M0.02, SCHEDULES: CHANGE: RTU-1 return fan CFM to 11,000. ADD: Key note to Fan Coil Unit Schedule for FC-3, 4 & 5: 6. Fan coil installed in mechanical closet with tight tolerances and design parameters. Contractor to verify adequate clearance if not providing basis of design. ADD: Key note to Fan Coil Unit Schedule for FC-1, 2 & 3: 7. Provide 3-way valve on heating water coil. ADD: Key note to Fan Coil Unit Schedule for FC-1 & 2: 7. Provide 3-way valve on cooling water coil. ADD: Key notes to Air Handling Unit Schedule for AHU-1: 2. Supply fan controlled by VFD (provided by AHU manufacturer). 3. Provide 3-way valve on heating and cooling water coils. SHEET M2.02, LEVEL 2 FLOOR PLAN - HYDRONICS: ADD: CO2 sensor adjacent to thermostats for FC-3, 4 & 5. SHEET M5.01, MECHANICAL CONTROL DIAGRAMS: CHANGE: Exterior Lighting Control Diagram detail number to 9.
53 54	<u>ADD:</u> To detail 1 DDC Controller: Occupancy Sensor, provided by Division 26. <u>CHANGE:</u> Detail 1 corresponding exhaust fan to EF-2.

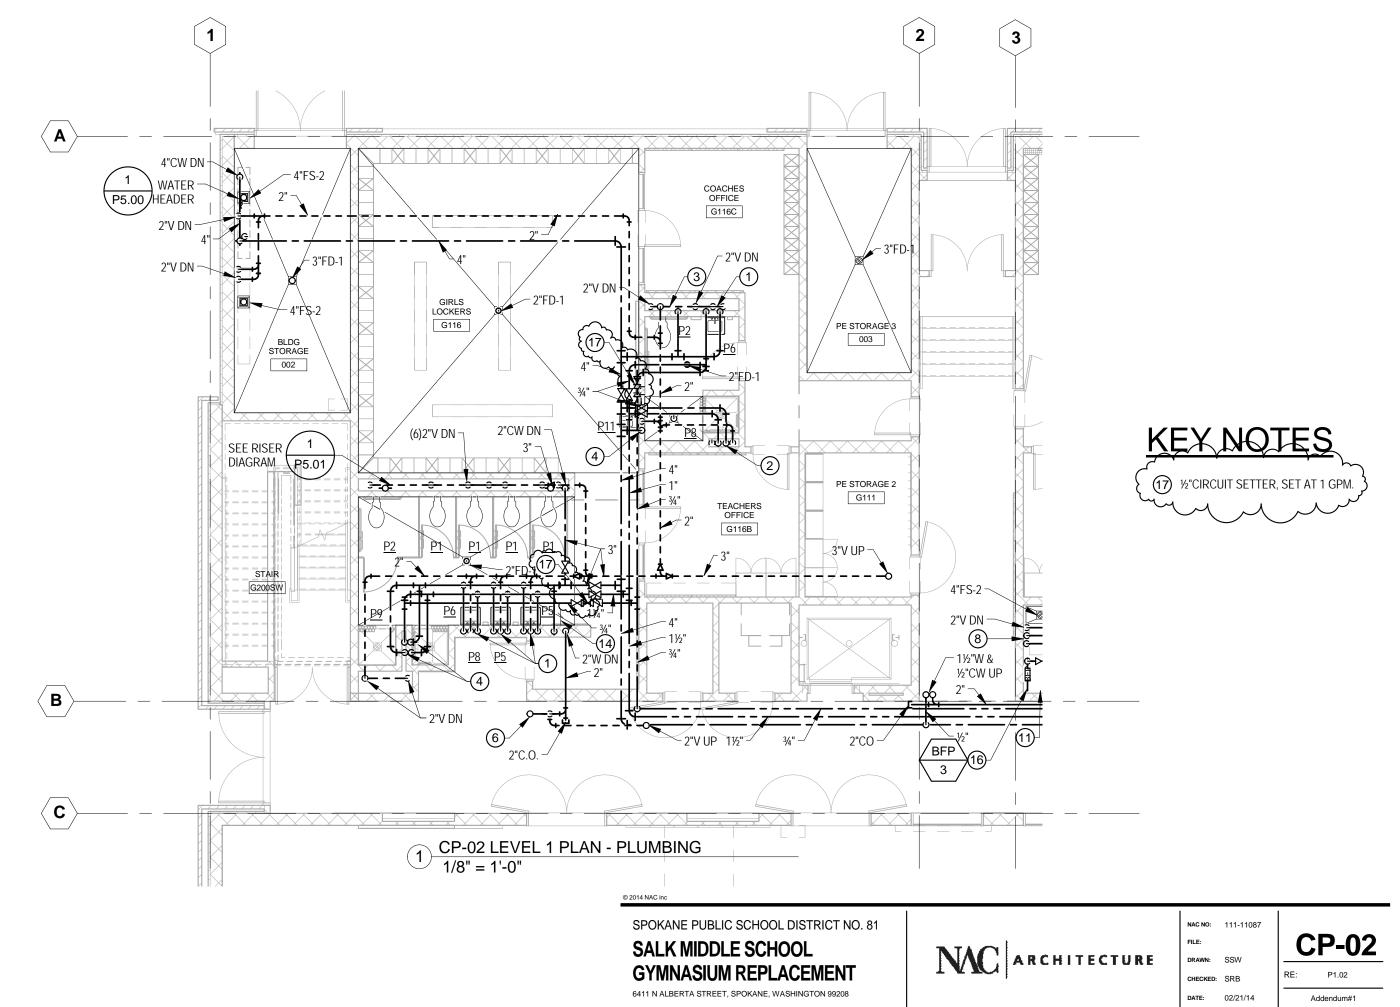
1	<u>REVISE</u> : Detail 1 Sequence of Operations applies only to FC-1 and 2.
2	<u>CHANGE:</u> Detail 1 Sequence of Operations first paragraph for Occupied Mode to read:
3	"FC-1 and FC-2 supply fans and exhaust fan EF-2 shall run continuously."
4	<u>CHANGE:</u> Detail 1 Sequence of Operations third paragraph for Unoccupied Mode to read:
5	"A push-button at the fan coil unit's room stat (T1) shall allow the system to override the
6	unoccupied cycle and place the fan coil unit the occupied mode for a pre-set time period of
7	2 hours (or as set). Placing either FC-1 or FC-2 into occupied override will also place the
8	remaining fan coil in occupied override mode. Exhaust fan EF-2 and roof top unit RTU-1
9	shall be energized for the corresponding 2 hour (or as set) occupied override time period to
10	provide outside and relief air."
11	<u>ADD:</u> To detail 2 DDC Controller: Occupancy Sensor, provided by Division 26.
12	<u>CHANGE:</u> Detail 2 corresponding exhaust fan to EF-1.
13	REVISE: Detail 2 Sequence of Operations applies only to FC-3, 4and 5.
14	ADD: General Note: 3-way valve only required for FC-3 heating water coil. All remaining coils to
15	be piped with 2-way valves.
16	
17	SHEET M5.04, MECHANICAL CONTROL DIAGRAMS:
18	<u>CHANGE:</u> Detail 1 Supply Duct Static Pressure DDC point to AI.
19	CHANGE: Detail 1 HRP-1 Pump Start/Stop DDC point to DO.
20	CHANGE: Detail 1 Dampers D-1, 2. 3 & 4 DDC point to AO.
21	<u>ADD:</u> To Detail 1 Sequence of Operations end of third paragraph for economizer cooling operation:
22	"During economizer operation and any time supply air flow exceeds 10,500 CFM, FC-1,
23	FC-2 and EF-2 shall energize (if not already commanded on by their respective occupancy
24	sensors) to provide relief air in addition to RTU-1."
25	ADD: To Detail 1 Sequence of Operations end of fourth paragraph for airflow control:
26	"Offset shall be maintained such that a differential of 1,000 CFM is maintained between the
27	supply and exhaust fans when the locker room exhaust fan (EF-2) is accounted for
28	(approximately 6,200 CFM)."
29	REVISE: Detail 1 Sequence of Operations Occupied Mode freeze protection to read:
30	"If the supply air temperature at T1 falls below 40F"
31	"If the supply air temperature at T1 falls below 30F"
32	<u>CHANGE:</u> Detail 2 chilled water coil to have 3-way control valve.
33	REVISE: Detail 2 Sequence of Operations first paragraph of Occupied Mode to read:
34	"The supply fan shall operate continuously and modulate its volume to provide the
35	minimum amount of outside air required for each fan coil. The minimum CFM for each fan
36	coil will vary from zero to the minimum CFM scheduled on the drawings based on the CO2
37	sensor in the space."
38	STEELS SPINIS
39	SHEET M5.05, MECHANICAL SYSTEM DRAWINGS:
40	<u>CHANGE:</u> Detail 2 Chilled Water System Drawing – 8" chilled water supply and return pipe
41	between chiller and key notes 28 (reducers at pump) on CHP-1 to be 6".
42	control chimer and hely notes 20 (reduceds at pump) on chi 1 to 00 0 .
43	

END OF MECHANICAL ADDENDUM NO. 1

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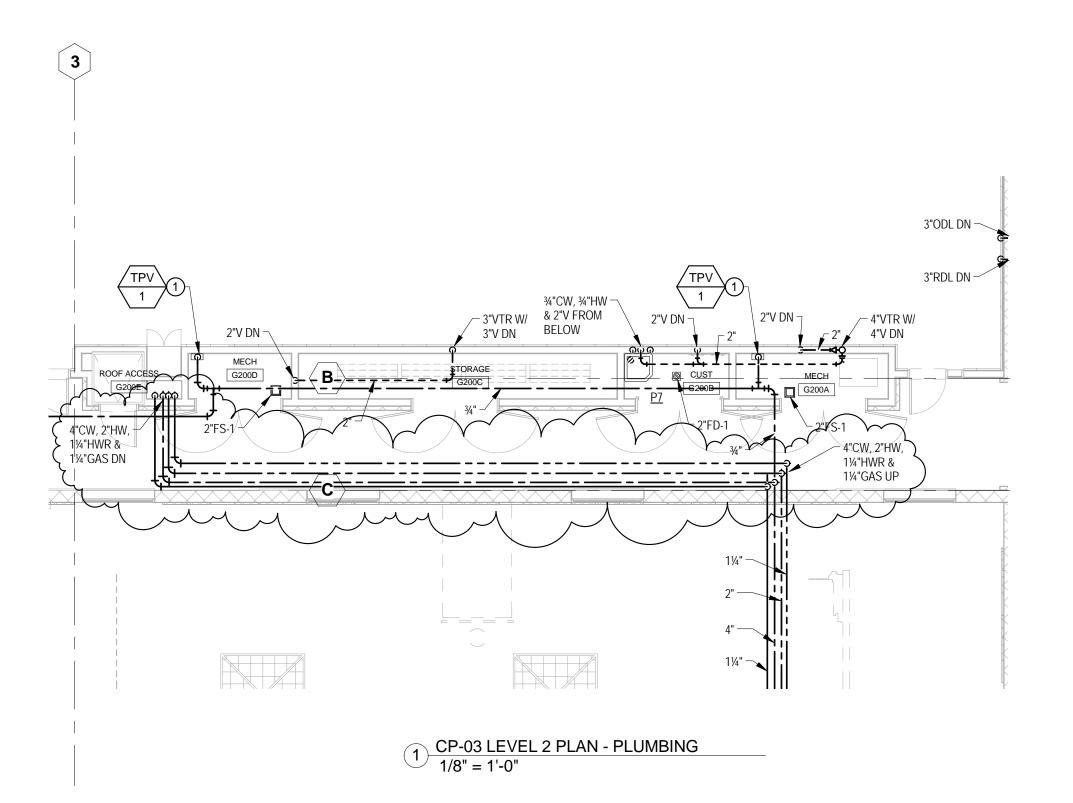
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6411 N ALBERTA STREET, SPOKANE, WASHINGTON 99208



NAC NO: 111-11087

FILE:

DRAWN: SSW

CHECKED: SRB

DATE: 02/21/14

RE: P1.02

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44 45

1 This Addendum is hereby made a part of the Contract Documents to the same extent as though it were 2 originally included therein. 3 4 5 ELECTRICAL 6 7 8 DRAWINGS: 9 SHEET E0.02. SCHEDULES: 10 11 ELECTRICAL KEYNOTE LEGEND ADD: Keynote L7 to read as follows: WALL MOUNT 84" ABOVE FLOOR. 12 13 ADD: Keynote P14 to read as follows: STUB RACEWAYS INTO PIT BELOW FUTURE 14 15 SWITCHBOARD. 16 ADD: Keynote P16 to read as follows: PROVIDE POWER CONNECTION TO FLAG 17 ROLLER AT ROOF STRUCTURE. 18 19 LUMINIARE SCHEDULE CHANGE: "Lamp type" for luminaire Type B68 to "LED." 20 21 22 SHEET E1.01, SITE PLAN - ELECTRICAL: ADD: New raceways between the existing building and the new building shall be installed below 23 the existing concrete walk along the west side of the existing building. Saw cut walk, install 24 25 raceway and replace walk to match existing. As an alternative, raceways may be pushed under the 26 walk. 27 SHEET E2.01. LEVEL 1 PLAN - LIGHTING: 28 29 ADD: Install Type C24S luminaires in rooms 002 and 003 per Electrical Keynote L7. 30 31 SHEET E3.02, LEVEL 2 PLAN - POWER: ADD: Make electrical connections to flag roller in room G101 per Electrical Keynote P16. See 32 33 drawing CE-01 34 SHEET E5.01, ENLARGED PLANS: 35 36 ELECTRICAL MECHANICAL ROOM 37 ADD: Extend underground raceways into pit per Electrical Keynote P14. 38 SHEET E6.01. POWER ONE-LINE DIAGRAM: 39 DETAIL 1, ONE-LINE POWER DIAGRAM 40 ADD: Raceways noted as "STUB-OUT FOR FUTURE" shall be install as indicated in 41 42 Electrical Keynote P14 and Electrical Keynote P10 on drawing E5.01. See drawing CE-02. 43

ADDENDUM NO. 1 February 21, 2014 Page E-2

PRIOR APPROVALS:

1 2 3

4 5

6

The following products are approved for bidding subject to review and approval of Submittals and provided the Manufacturer meets all the requirements of the originally specified product. It shall be the initiator's responsibility to ensure that the proposed substitution is equal in every respect to the originally specified product, including but not limited to finish, size, weight, clearances, durability, maintenance, ease of operation, performance criteria, etc.

7 8

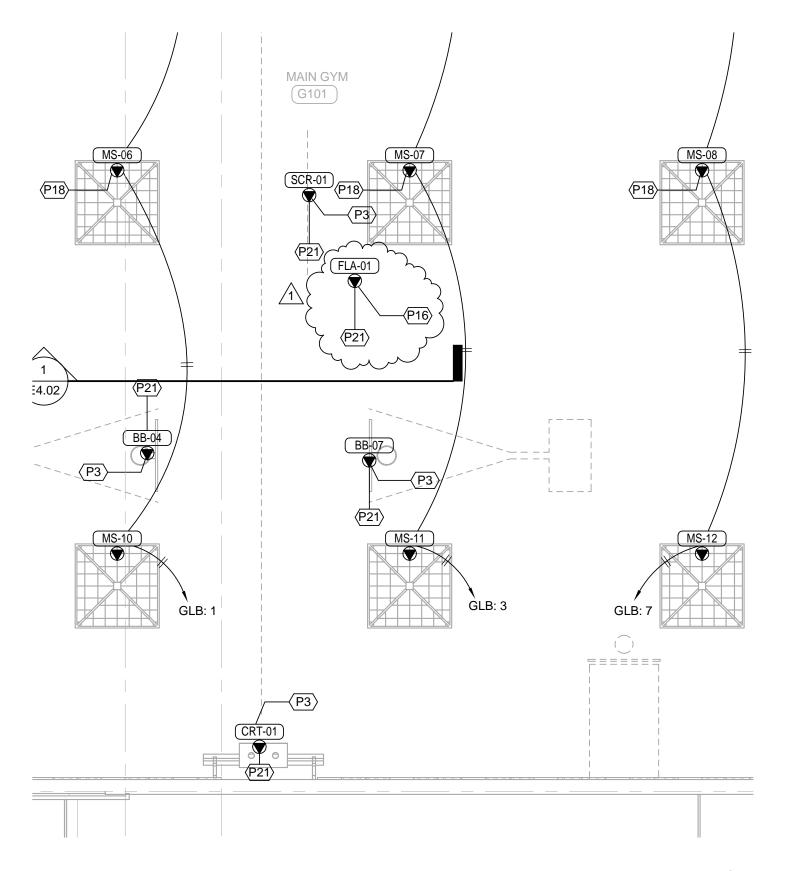
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9	SECTION 26 5	1 00 – INTERIOR LIGHTING
10	B01:	MULE #ELS-BB
11	B66:	PATHWAY #6SQLED
12		ZUMTOBEL #BS6DLED
13	B66E:	PATHWAY #6SQLED
14		ZUMTOBEL #BS6DLED
15	B68:	PATHWAY #6SQLED
16		ZUMTOBEL #BS6DLED
17	F28:	AXIS #TB S/S
18		ZUMTOBEL #SL2
19	F28E:	AXIS #TB S/S
20		ZUMTOBEL #SL2
21	S01:	LITHONIA #WST-LED

END OF ELECTRICAL ADDENDUM NO. 1

26 27

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LEVEL 2 PLAN - POWER

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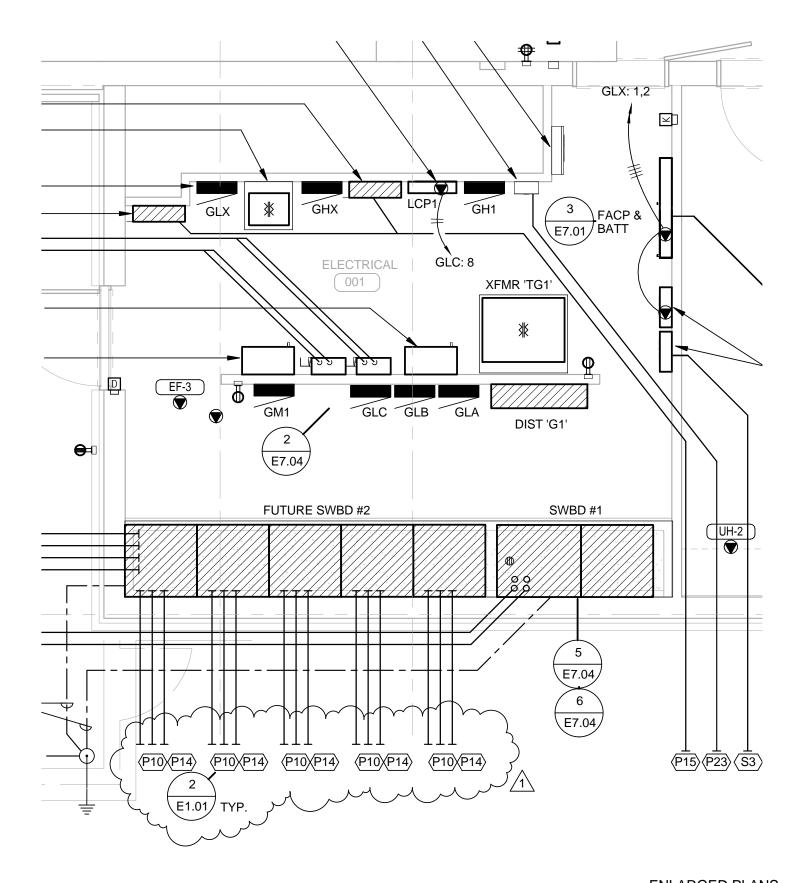


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CE-01

ADDENDUM #1



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CE-02

111-11087

ADDENDUM #1

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